
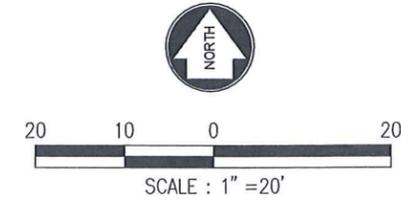


L:\110172-010\CAD\CIVIL\110172-010_PRR02-5.DWG
 LAYOUT: SITE P02 | BY: JREGELBERGER | DATE: 5/14/2012
 XREF DWG1: NONE | XREF DWG2: NONE
 XREF DWG3: NONE | XREF DWG4: NONE

NOTE:
 ALL DISTURBED AREAS TO BE SEEDD ONCE
 CONSTRUCTION IS COMPLETE.

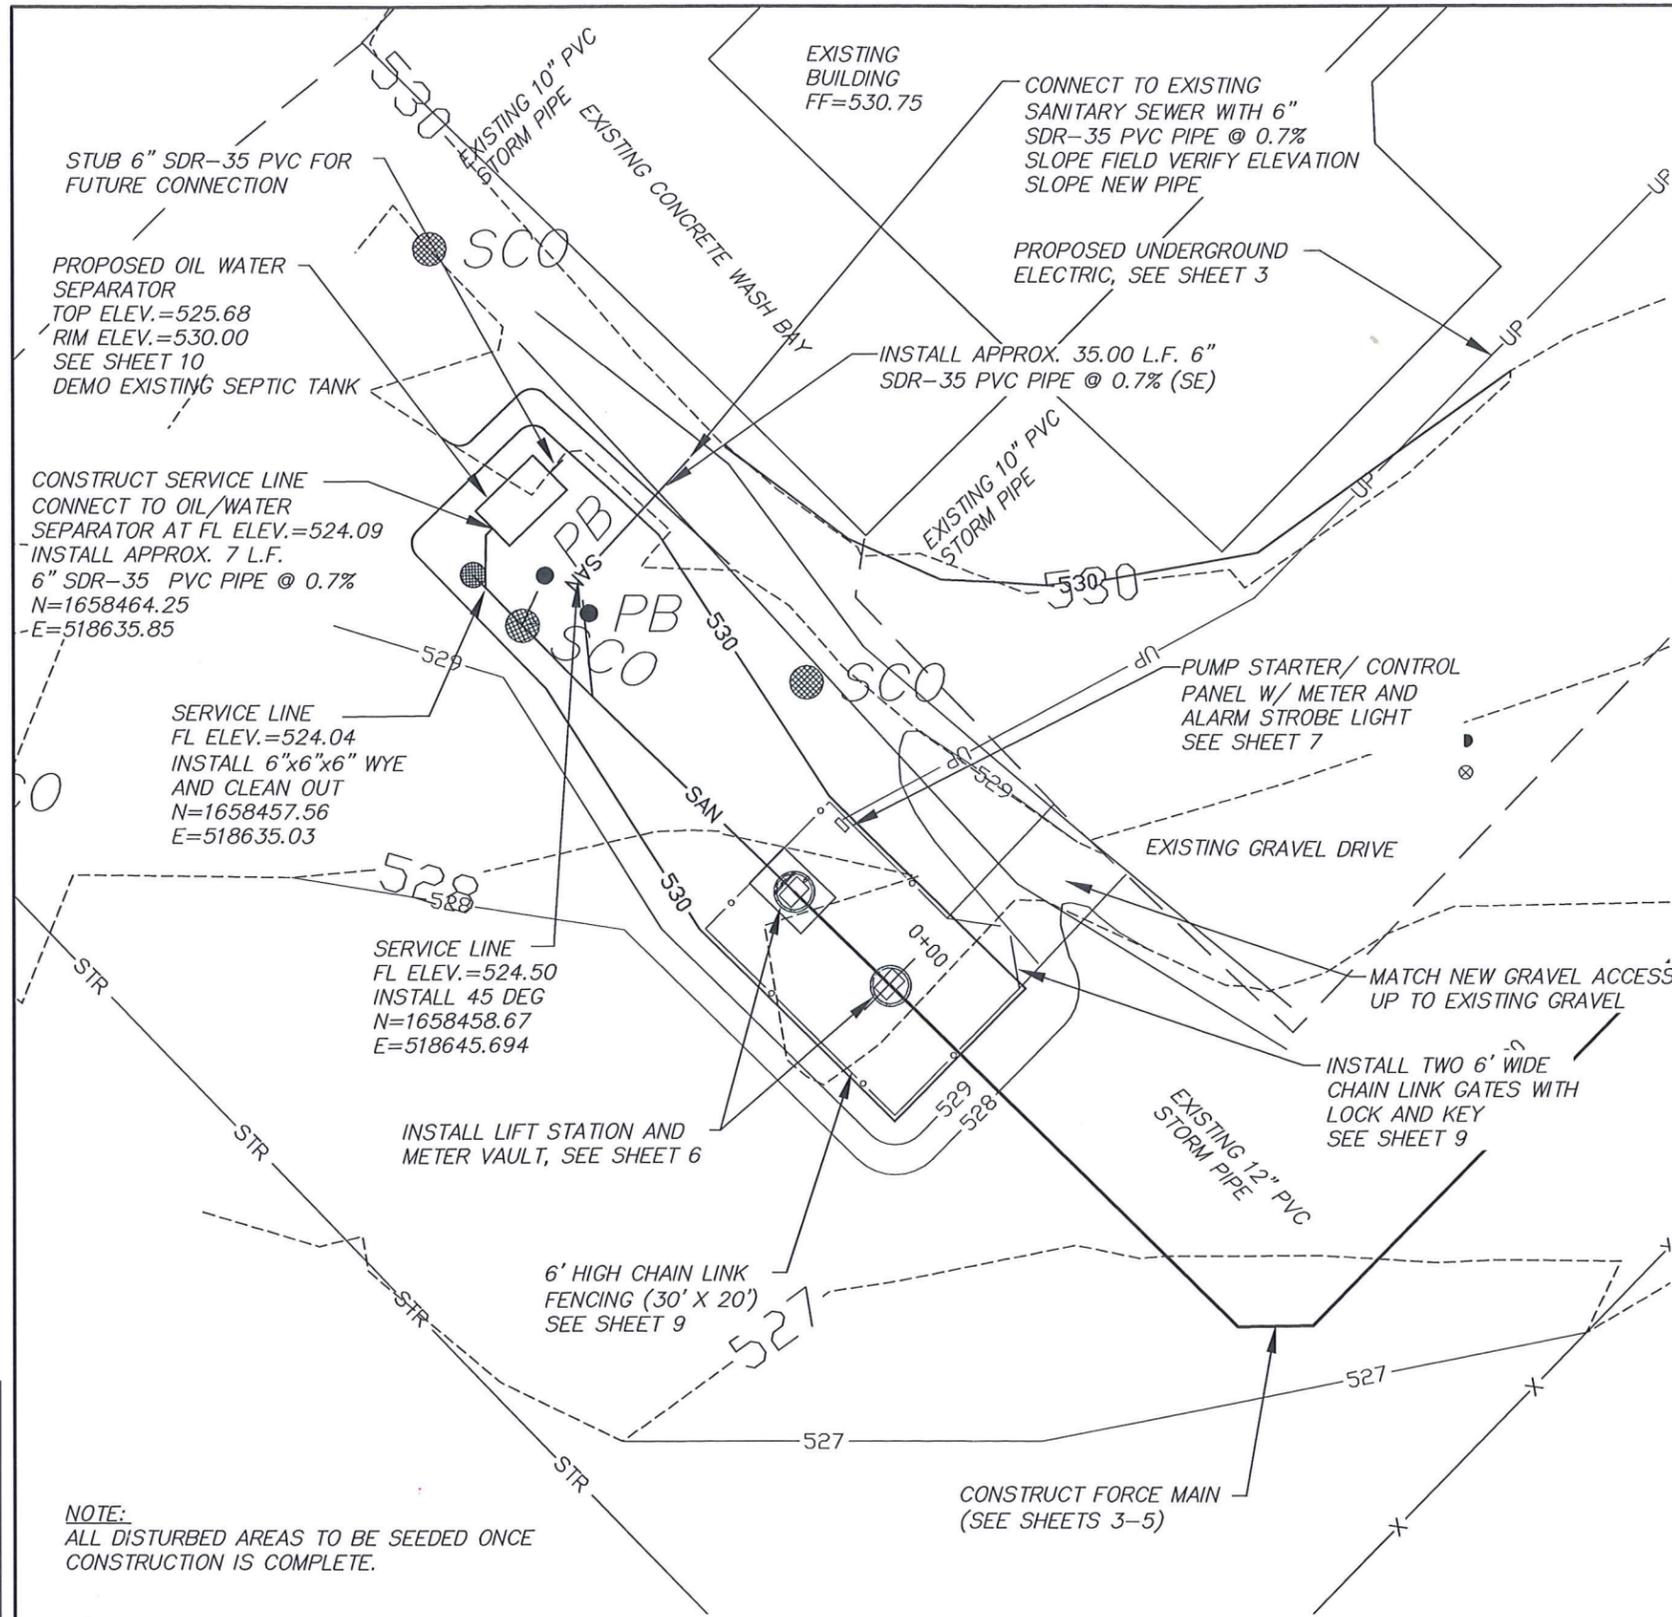

LEGEND

- | | | | |
|----------|------------------------------------|--------|---------------------|
| ● IB_E | EXISTING IRON BAR | ⊙ H&V | CONTROL POINT |
| ● IBPC_E | EXISTING IRON BAR WITH PLASTIC CAP | ⊕ TBM | TEMPORARY BENCHMARK |
| ● SSMH | SANITARY SEWER MANHOLE | ● FPST | FENCE POST |
| WM | WATER METER | ○ WP | WOOD POST |
| WV | WATER VALVE | ⊠ STNP | STONE POST |
| △ WFCT | WATER FAUCET | □ MB | MAIL BOX |
| ⊠ RW | RIGHT-OF-WAY MARKER | ⊙ | TREE |
| ⊙ FH | FIRE HYDRANT | ⊙ | BUSH |
| □ TEP | TELEPHONE PEDESTAL | | |
| ▶ WS | WOOD SIGN | | |
| ▼ MS | METAL SIGN | | |
| ⊕ GA | GUY ANCHOR | | |
| ⊕ PP | POWER POLE | | |
| ⊕ PPU | POWER POLE W/UNDERGROUND | | |
| ⊕ PPT | POWER POLE WITH TRANSFORMER | | |
| | LIGHT POLE | | |
| ⊕ PRISR | POWER RISER | | |
| ⊕ TP | TELEPHONE POLE | | |
| ● TMH | TELEPHONE MANHOLE | | |
| ⊙ GREG | GAS REGULATOR | | |



STEVEN R. SCHULTZ
 PE-2001004664

5	DESIGNED BY: SRS	NO.	DATE	REVISIONS	BY	APPD
4	DRAWN BY: CLC	1	5/14/12	MOVED OIL/WATER SEPARATOR	JWR	PW
3	CHECKED BY: SRS	2	5/14/12	CHANGED PIPING & GRADING	JWR	PW
2	ISSUE DATE: 4.19.2012	3	5/14/12	CHANGED FOREMAN ALIGNMENT	JWR	PW
1		4				

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 1400 Forum Boulevard, Suite 19A, Columbia, MO 65203-1997
 573/442-4537 FAX: 573/442-4543



OFFICE LOCATIONS:
 Chillicothe, MO
 Columbia, MO
 Houston, TX
 Idaho, KS
 Kansas City, MO
 Lenexa, KS
 Meoson, MO
 Nixa, MO
 Nixa, OK
 Tulsa, OK

SKW
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L:\10172-010_CAD\CIVIL\10172-010_PRR2-5.DWG
 LAYOUT: PP PGS
 BY: JREIGELBERGER DATE: 9/14/2012
 XREF DWG1: NONE
 XREF DWG2: NONE
 XREF DWG3: NONE




STEVEN R. SCHULTZ
 PE-2001004664

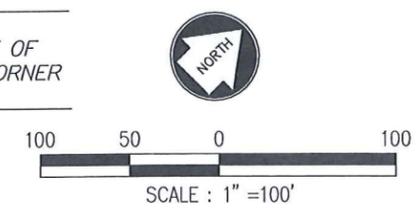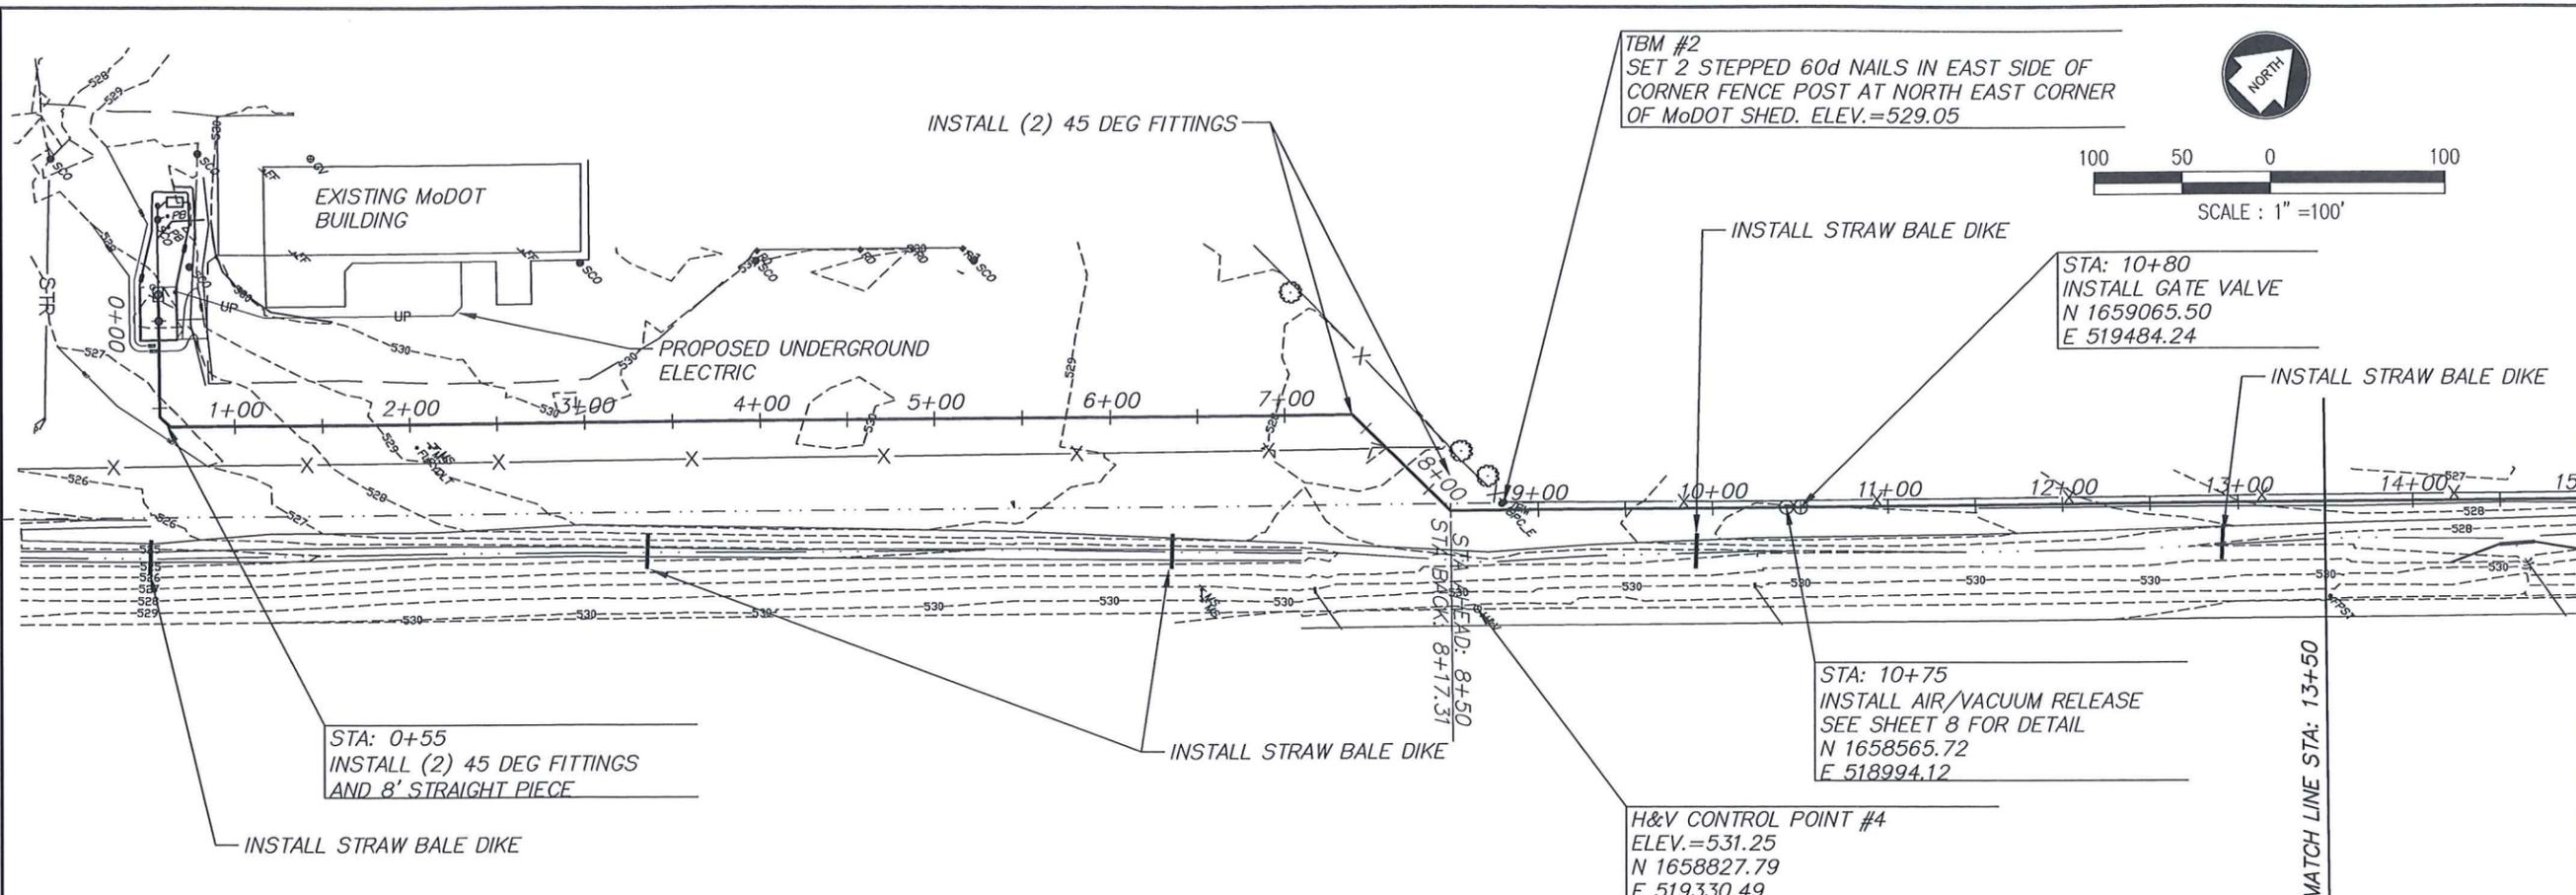

NOTES:
 1. CONTRACTOR HAS THE OPTION OF DIRECTIONAL BORING ENTIRE JOB WITH 2" FUSION-WELD SDR-11 WITH PRESSURE RATING OF 160psi
 2. CONTRACTOR SHALL PLACE FORCEMAIN WITHIN 6.0' UTILITY CORRIDOR WHERE FEASIBLE.

SCALE:
 HORIZONTAL: 1"=100'
 VERTICAL: 1"=10'

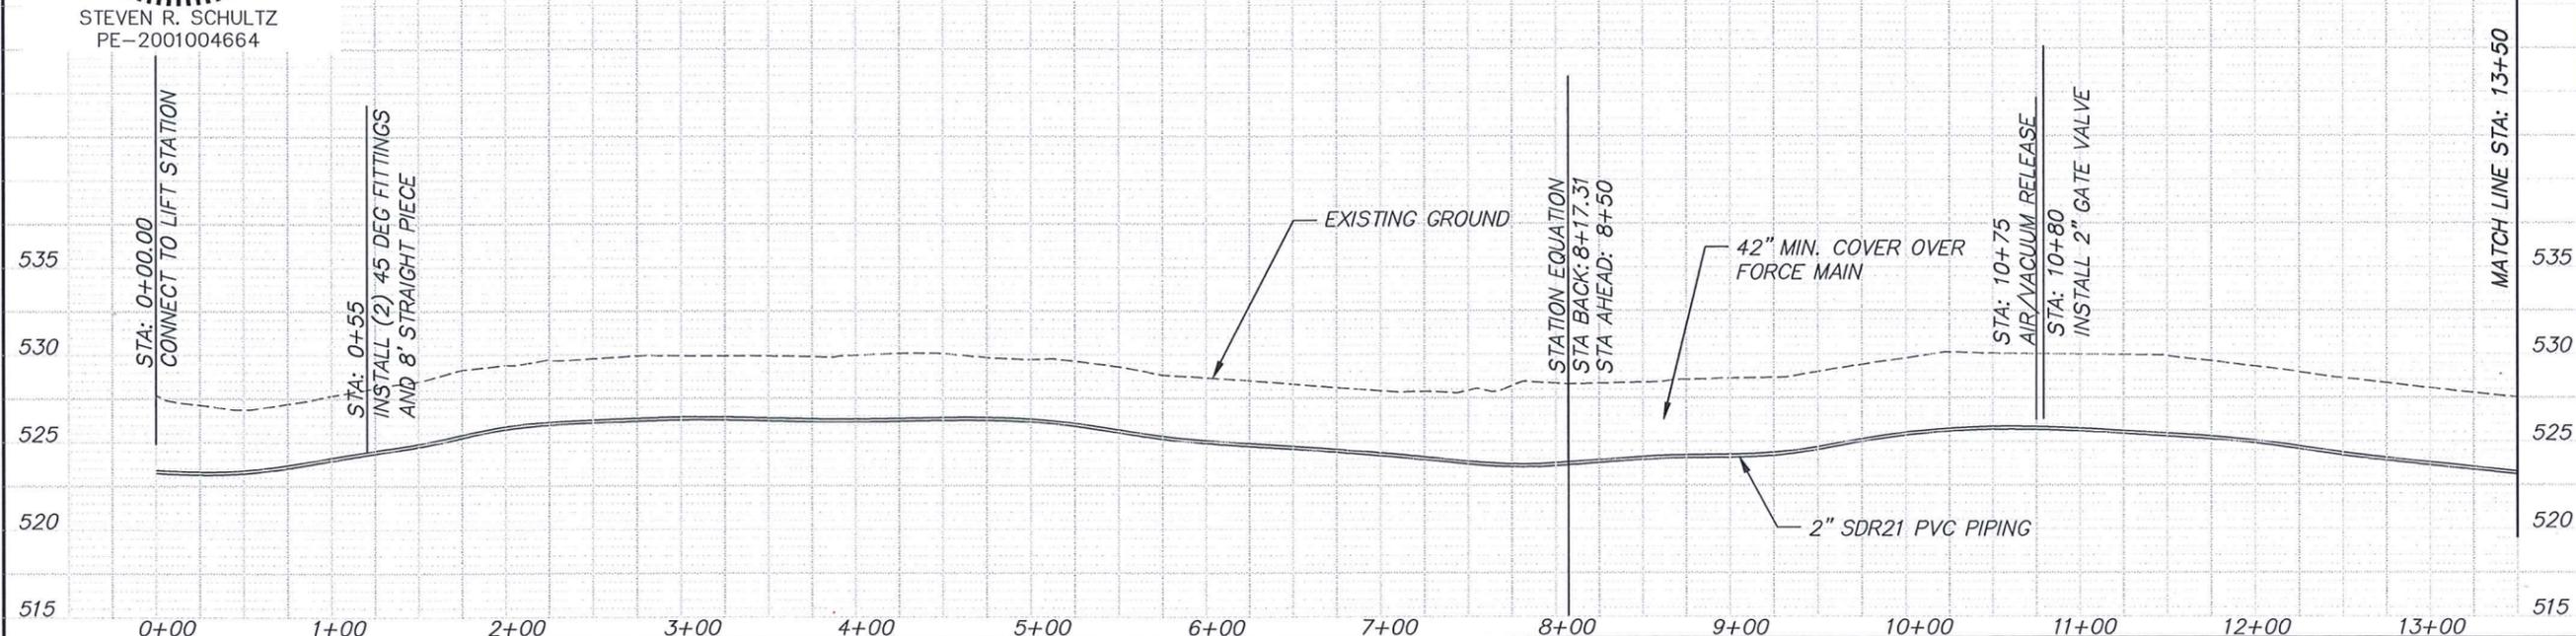

5	DESIGNED BY: SRS	NO.	DATE	REVISIONS	JWR	FW
4	DRAWN BY: CLC	1	5/14/12	CHANGED FORCEMAIN ALIGNMENT		
3	CHECKED BY: SRS	2				
2	ISSUE DATE: 4.19.2012	3				
1		4				
		5				

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PLAN & PROFILE
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110172-010
 SHEET NO.
3 OF **10**

